



BUILDING CODE COMPLIANCE OFFICE (BCCO)
PRODUCT CONTROL DIVISION

MIAMI-DADE COUNTY, FLORIDA
METRO-DADE FLAGLER BUILDING
140 WEST FLAGLER STREET, SUITE 1603
MIAMI, FLORIDA 33130-1563
(305) 375-2901 FAX (305) 375-2908

NOTICE OF ACCEPTANCE (NOA)

Therma-Tru Corporation
108 Mutzfeld Road
Butler, IN 46721

SCOPE:

This NOA is being issued under the applicable rules and regulations governing the use of construction materials. The documentation submitted has been reviewed by Miami-Dade County Product Control Division and accepted by the Board of Rules and Appeals (BORA) to be used in Miami Dade County and other areas where allowed by the Authority Having Jurisdiction (AHJ).

This NOA shall not be valid after the expiration date stated below. The Miami-Dade County Product Control Division (In Miami Dade County) and/or the AHJ (in areas other than Miami Dade County) reserve the right to have this product or material tested for quality assurance purposes. If this product or material fails to perform in the accepted manner, the manufacturer will incur the expense of such testing and the AHJ may immediately revoke, modify, or suspend the use of such product or material within their jurisdiction. BORA reserves the right to revoke this acceptance, if it is determined by Miami-Dade County Product Control Division that this product or material fails to meet the requirements of the applicable building code.

This product is approved as described herein, and has been designed to comply with the High Velocity Hurricane Zone of the Florida Building Code.

DESCRIPTION: "Benchmark" & "Legend" Inswing Residential Insulated Steel Door-Impact Resistant

APPROVAL DOCUMENT: Drawing No. ED-1702-B, titled "Inswing Residential Insulated Steel Door with Wood Frame", sheets 1 through 5 of 5, prepared, by Rick Wright Consulting, dated 2/21/99, bearing the Miami-Dade County Product Control Renewal stamp with the Notice of Acceptance number and expiration date by the Miami-Dade County Product Control Division.

MISSILE IMPACT RATING: Large and Small Missile Impact

LABELING: Each unit shall bear a permanent label with the manufacturer's name or logo, city, state and following statement: "Miami-Dade County Product Control Approved", unless otherwise noted herein.

RENEWAL of this NOA shall be considered after a renewal application has been filed and there has been no change in the applicable building code negatively affecting the performance of this product.

TERMINATION of this NOA will occur after the expiration date or if there has been a revision or change in the materials, use, and/or manufacture of the product or process. Misuse of this NOA as an endorsement of any product, for sales, advertising or any other purposes shall automatically terminate this NOA. Failure to comply with any section of this NOA shall be cause for termination and removal of NOA.

ADVERTISEMENT: The NOA number preceded by the words Miami-Dade County, Florida, and followed by the expiration date may be displayed in advertising literature. If any portion of the NOA is displayed, then it shall be done in its entirety.

INSPECTION: A copy of this entire NOA shall be provided to the user by the manufacturer or its distributors and shall be available for inspection at the job site at the request of the Building Official.

This NOA **renews NOA # 97-0930.09** and, consists of this page 1 as well as approval document mentioned above. The submitted documentation was reviewed by **Raul Rodriguez**.



NOA No 02-0408.03
Expiration Date: May 30, 2007
Approval Date: May 09, 2002
Page 1

BENCHMARK / LEGEND

INSWING RESIDENTIAL INSULATED STEEL DOOR WITH WOOD FRAMES.

GENERAL NOTES

1. THIS PRODUCT IS DESIGNED TO MEET THE SOUTH FLORIDA BUILDING CODE 1994 EDITION FOR MIAMI-DADE COUNTY.
2. WOOD BUCKS BY OTHERS, MUST BE ANCHORED PROPERLY TO TRANSFER LOADS TO THE STRUCTURE.
3. PRODUCT ANCHORS SHALL BE AS LISTED AND SPACED AS SHOWN ON DETAILS. ANCHOR EMBEDMENT TO BASE MATERIAL SHALL BE BEYOND WALL DRESSING OR STUCCO.
4. IMPACT RESISTANT SHUTTERS NOT REQUIRED
5. DESIGNED PRESSURE RATING SHALL BE AS FOLLOWS:
 - FOR UP TO 6'8" WOOD FRAMES; SEE TABLE ON SHEET 2
 - FOR UP TO 8'0" WOOD FRAMES; SEE TABLE ON SHEET 3

RESIDENTIAL INSULATED STEEL DOOR (Common to all frame conditions)


Door Leaf Construction:

Face sheets: 24 ga. (0.024") minimum thickness, Galvanized steel A-525 commercial quality - AKDQ per ASTM 620 with yield strength $F_y(\text{ave.})=23,300$ psi.
Core design: Polyurethane core, two-parts Isocyanate Resin components foam, with 2.15 lbs. density.

Construction: Flush or embossed type. The vertical edges are extensions of the skin, rolled formed to a mechanical interlock, horizontal edges are welded together at two places each.

TABLE OF CONTENTS

SHEET #	DESCRIPTION
1	COMMON (GENERAL NOTES, TYPICAL ELEVATION)
2	6'8" WOOD FRAME (BILL OF MATERIAL, ANCHORS, ELEVATION)
3	8'0" WOOD FRAME (BILL OF MATERIAL, ANCHORS, ELEVATION)
4	WOOD FRAME CROSS SECTIONS
5	COMMON (DOOR MODELS, LOCK DETAILS)

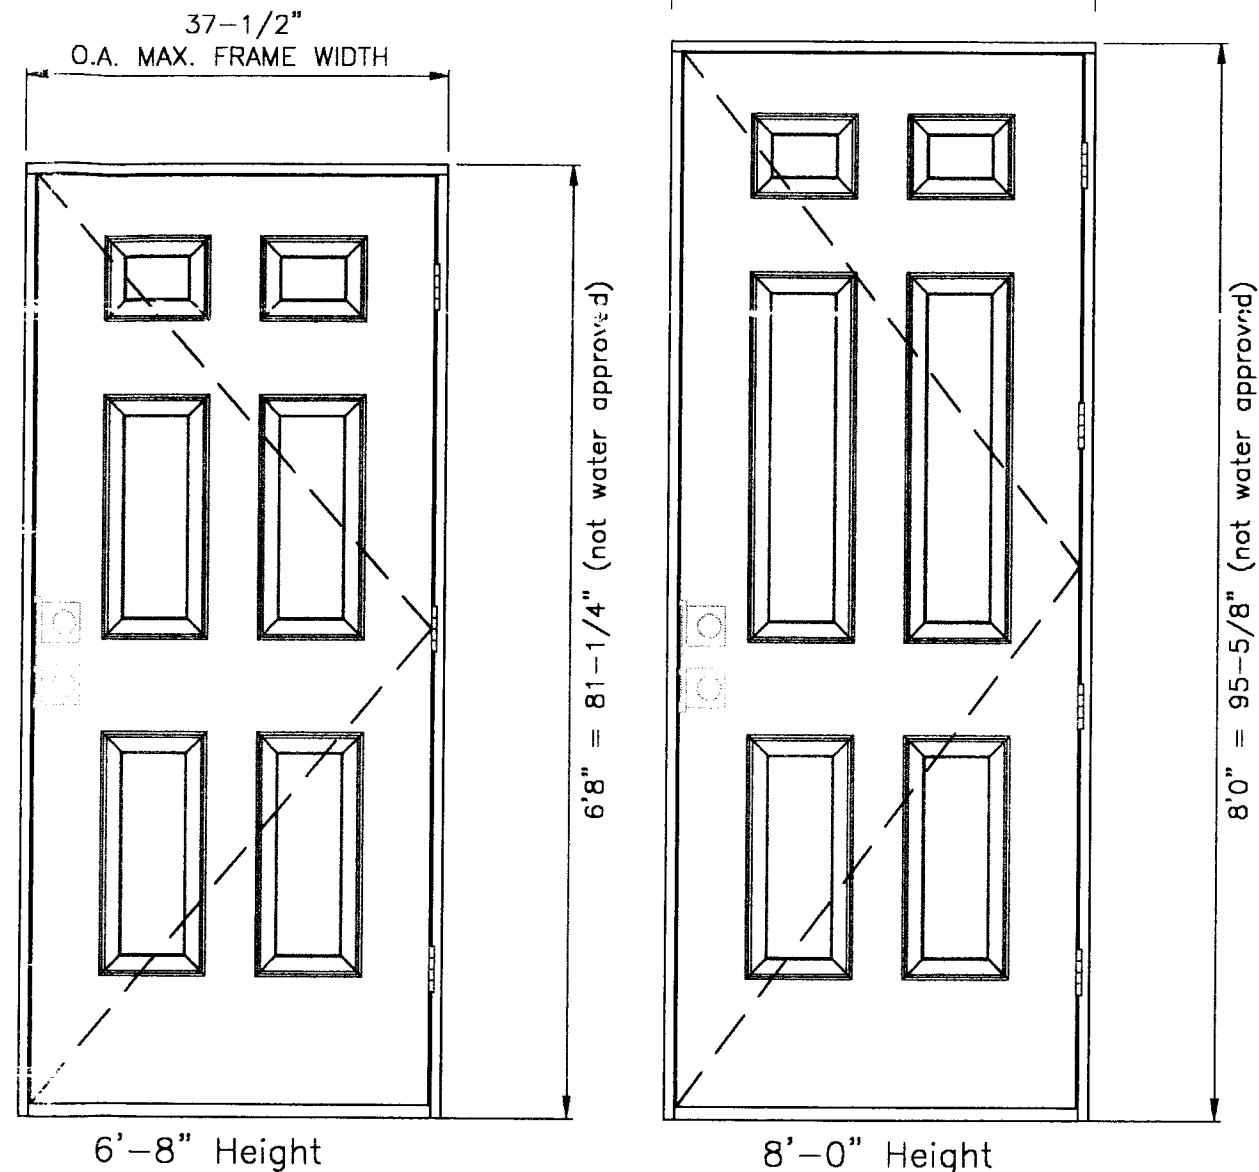

COLONIAL 6 PANEL DOOR VIEWED FROM INTERIOR

(SHOWN FOR CLARITY OF VIEW)

APPROVED AS COMPLYING WITH THE
SOUTH FLORIDA BUILDING CODE

PRODUCT RENEWED
as complying with the Florida
Building Code
Acceptance No. 02-0408.03
Expiration Date 05/30/07
By *[Signature]*
Miami Dade Product Control
Division

DATE *May 20* 1999
BY *Maemel [Signature]*
PRODUCT CONTROL DIVISION
BUILDING CODE COMPLIANCE OFFICE
ACCEPTANCE NO. 97-0930-09

DATE: 2/21/99
SCALE: N.T.S.
DWG. BY: C.E.C.
CHK. BY:
DRAWING NO.:
ED-1/02-B
SHEET 1 OF 5

PRODUCT:

INSWING RESIDENTIAL
INSULATED STEEL DOOR
WITH WOOD FRAME

PART OR ASSEMBLY:

GENERAL NOTES
AND ELEVATIONS

BY

NO.

DATE


REVISIONS

GENERAL PRODUCTS CO., INC.
P.O. BOX 7387
FREDERICKSBURG, VA 22404
PH. (540) 898-5700



RW
CONSULTING
(813) 684-3831

ITEM	DESCRIPTION
1	Latch jamb (1-1/4" x 4-1/2" Wood Jamb)
2	Hinge jamb (1-1/4" x 4-1/2" Wood Jamb)
3	Head jamb (1-1/4" x 4-1/2" Wood Jamb)
4	Benchmark 4" x 4" butt hinges 12ga.(.097") C.R steel
6	#10-24 x 5/8" PFH wood screw (hinge to frame)
7	#10-24 x 3" PFH wood screw
8	#10 x 2-1/2" PFH wood screw
9	3/16" tapcon (1-1/4" into masonry)
10	Saddle (barrier free) threshold 1/2 x 4 x 1/8" extruded alum.
11	One piece aluminum threshold (proprietary)
13	Compression weatherstrip Schlegel Q-Lon QDS 650
14	Magnetic weatherstrip TPE
16	Face sheet 24ga.(.024 thk.min)galv.steel A-525 Fy=23,000 psi.
17	Hinge steel reinforcement for door (.055" x 1-1/8" x 5-1/4")
18	Corner foamstop
20	Foam fill hole plug
21	Cross bore reinforcement wood block
22	Face plate filler for latch
23	Face plate filler for deadbolt
24	Door sweep (not req'd with bump face threshold)
25	#8 x 1/2" lg. type "AB" PH. SMS.
26	#8 x 2" lg. PFH. wood screw
27	Kwikset titan series lock
27a	Weslock series 1800 lock
27b	Kwikset series 200 DL passage
27c	Kwikset series 400 DL passage
27d	Kwikset 680 lock
28	Kwikset titan series deadbolt
28a	Weslock series 1800 deadbolt
28b	Kwikset 660 deadbolt
28c	Kwikset 660 deadbolt
28d	Kwikset 680 deadbolt
29	Latch screws (see lock manufacturer's instructions)
30	Masonry wall
31	2x wood buck
32	Polyurethane (isocyanate & resin) foam (2.15 pounds density)
33	1/4" max. shim space

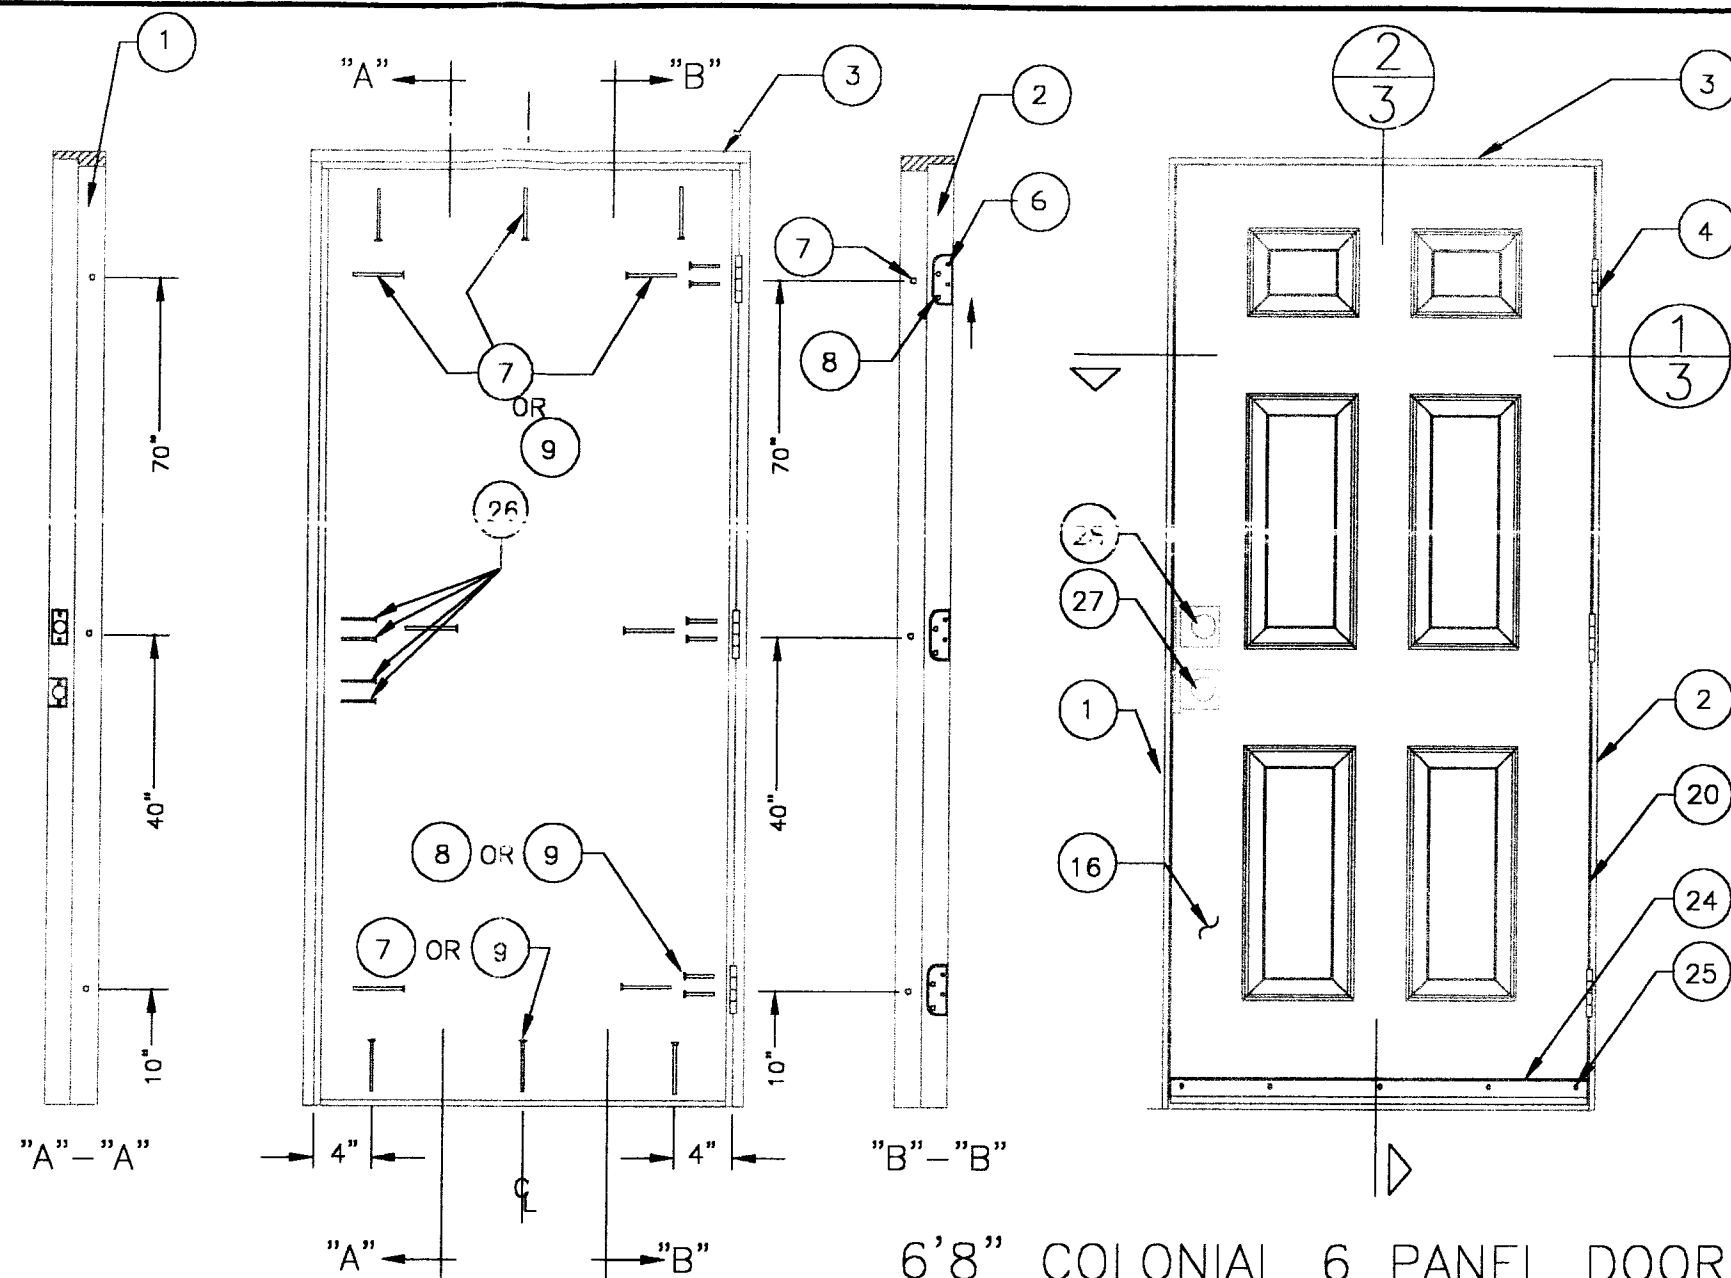

ANCHOR LOCATIONS

6'8" COLONIAL 6 PANEL DOOR VIEWED FROM INTERIOR (SHOWN FOR CLARITY OF VIEW)

DESIGN PRESSURE RATING		
<div style="background-color: #cccccc; width: 100px; height: 100px;"></div>	POSITIVE	+76 PSF
	NEGATIVE	-86 PSF

APPROVED AS COMPLYING WITH THE

PRODUCT RENEWED
as complying with the Florida
Building Code
Acceptance No. 02-0408.03
Expiration Date 05/30/07
By: *[Signature]*
Miami Dade Product Control
Division

SOUTH FLORIDA BUILDING CODE
DATE: May 20, 1999
BY: *[Signature]*
PRODUCT CONTROL DIVISION
BUILDING CODE COMPLIANCE OFFICE
ACCEPTANCE NO. 97-0930.07

DATE: 2/21/99

SCALE: N.T.S.

DWG. BY: C.E.C.

CHK. BY:

DRAWING NO.:

ED-1702-B

SHEET 2 OF 5

FOR: RESIDENTIAL WOOD FRAME CROSS-SECTION LAYOUT, SEE: ED-1702-B / SHEET 3 OF 5
FOR: RESIDENTIAL DOOR PREPARATION LAYOUT, SEE: ED-1702-B / SHEET 5 OF 5

GENERAL PRODUCTS CO. INC.
P.O. BOX 7387
FREDERICKSBURG, VA 22404
PH. (540) 898-5700

PRODUCT:
INSWING RESIDENTIAL
INSULATED STEEL DOOR
WITH WOOD FRAME

PART OR ASSEMBLY:

GENERAL NOTES
AND ELEVATIONS

REVISIONS

NO. DATE BY

Technical drawing of a window assembly, showing two views: a side elevation (left) and a front elevation (right).

Side Elevation (Left):

- Vertical dimensions: 1' 1", 7", 32-1/2", 58", 83-1/2".
- Horizontal dimensions: "A", "B", 4".
- Callouts: 1, 2, 3, 4, 6, 7, 8, 9, 16, 20, 24, 25, 27, 28.
- Section line: "A-A".

Front Elevation (Right):

- Vertical dimensions: 7", 32-1/2", 58", 93-1/2".
- Horizontal dimensions: "A", "B", 4".
- Callouts: 1, 2, 3, 4, 6, 7, 8, 9, 16, 20, 24, 25, 27, 28.
- Section line: "B-B".

8'0" COLONIAL 6 PANEL DOOR
VIEWED FROM INTERIOR

(SHOWN FOR CLARITY OF VIEW)

APPROVED AS COMPLYING WITH THE
SOUTH FLORIDA BUILDING CODE

DATE May 20 - 1999
BY Mmanuel Perez
PRODUCT CONTROL DIVISION
BUILDING CODE COMPLIANCE OFFICE
ACCEPTANCE NO. 97-0930.09

GENERAL PRODUCTS CO. INC.
P.O. BOX 7387
FREDERICKSBURG, VA 22404
PH. (540) 898-5700



PRODUCT: INSWING RESIDENTIAL
INSULATED STEEL DOOR
WITH WOOD FRAME

FOR ASSEMBLY:
GENERAL NOTES
AND ELEVATIONS

REVISIONS

Y

DATE

ON

RW

CONSULTING
(813) 684-3831

DATE: 2/21/99

SCALE: N.T.S.


DWG. BY: C.E.C.

CHK. BY:

DRAWING NO.:

ED-1702-B

SHEET 3 OF 5

DESIGN PRESSURE RATING		
		WHERE WATER INFILTRATION REQUIREMENT IS NOT NEEDED
POSITIVE		+70 PSF
NEGATIVE		-80 PSF

PRODUCT RENEWED
as complying with the Florida
Building Code
Acceptance No. 02-0408.03
Expiration Date 05/30/07
By [Signature]
Miami Dade Product Control
Division

FOR: RESIDENTIAL WOOD FRAME CROSS-SECTION LAYOUT, SEE: ED-1702-B / SHEET 3
FOR: RESIDENTIAL DOOR PREPARATION LAYOUT, SEE: ED-1702-B / SHEET 5

